


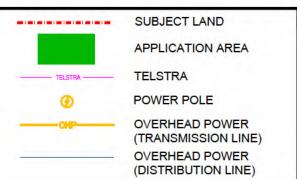

TOTAL AREA LOT 1449	18.98ha
AREA SUBJECT TO APPLICATION	1.60ha
CITY OF GREATER GERALDTON LOCAL PLANNING SCHEME No. 1 ZONING	RURAL
USE CLASS - WORKERS ACCOMMODATION	A*


granting development approval after giving notice in accordance with clause 64 of the deemed




PROPOSED SHORT-STAY ACCOMMODATION LOT 1449 (58) GILES ROAD MOONYOONOOKA, WA LOCATION PLANS

DRAWN LS	PRINCIPAL	REDUCTION 0 25
DESIGNED LS	LS	23
SCALE	DATE	DRAWING No.
NTS	JULY 2025	1 04
ERWA PROJ No. ERWA25085	ERWA Job No.	A.01

THIS IS A CADD DRAWING DO NOT AMEND MANUALLY

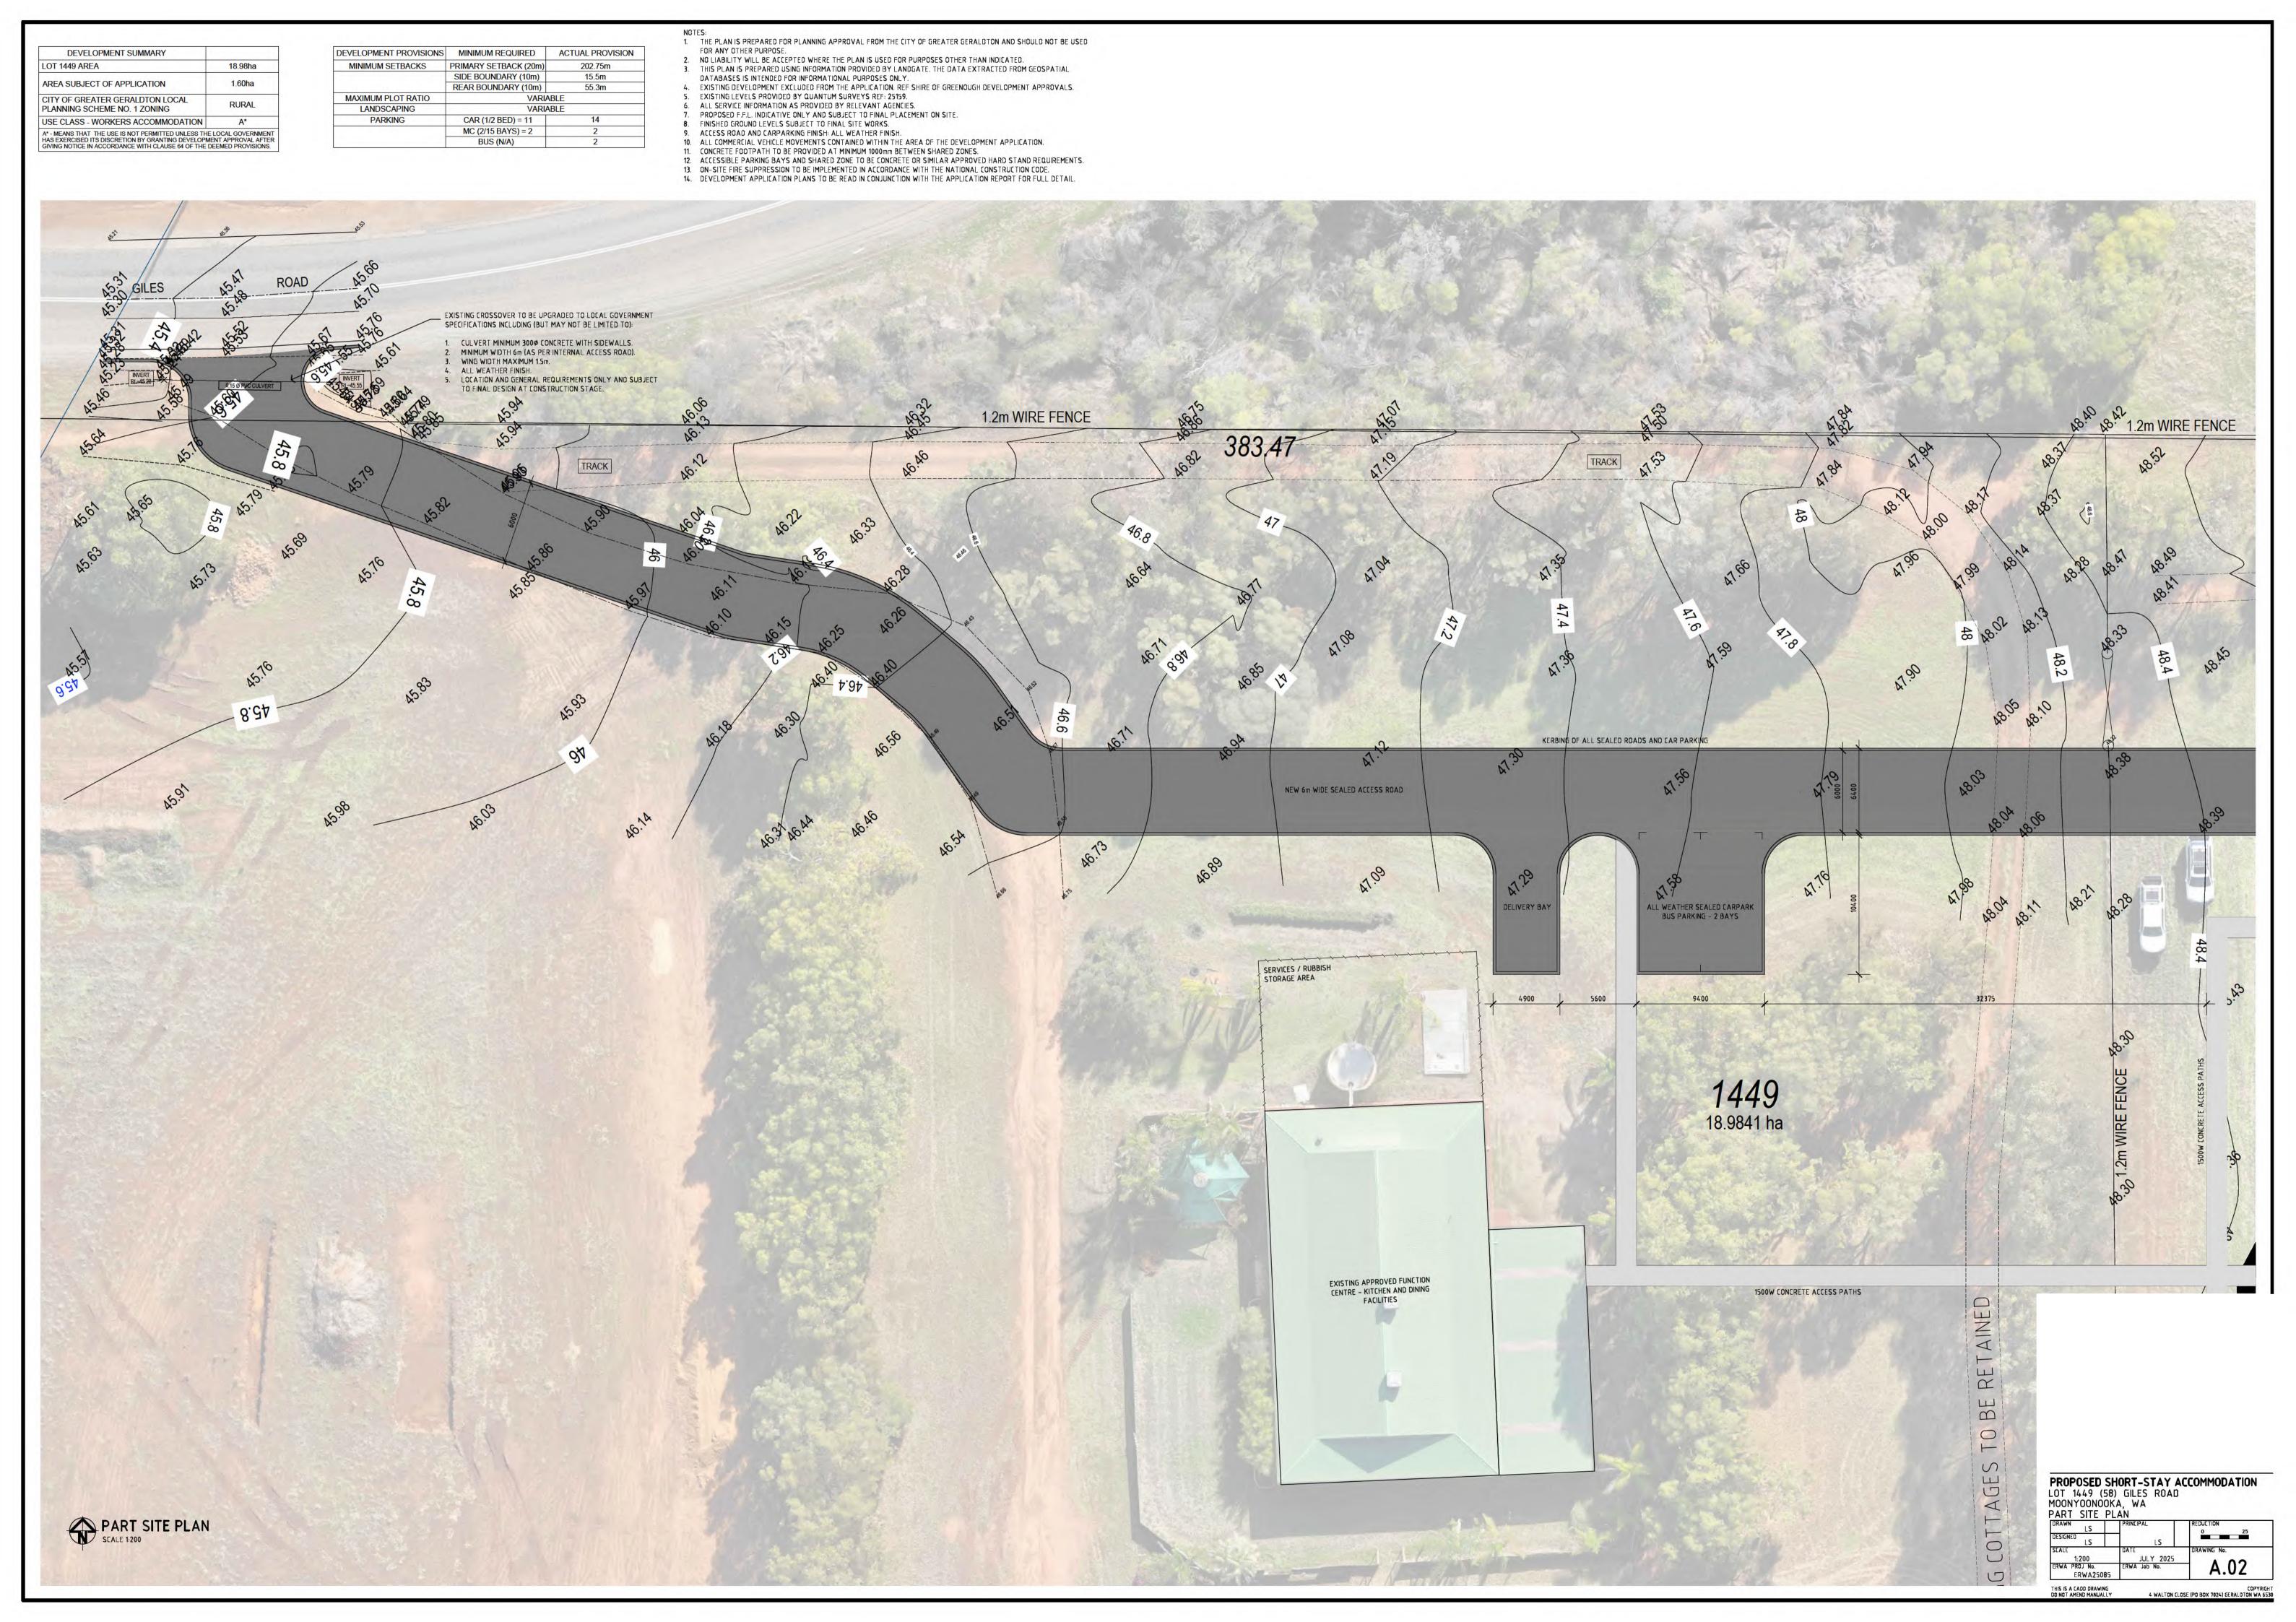

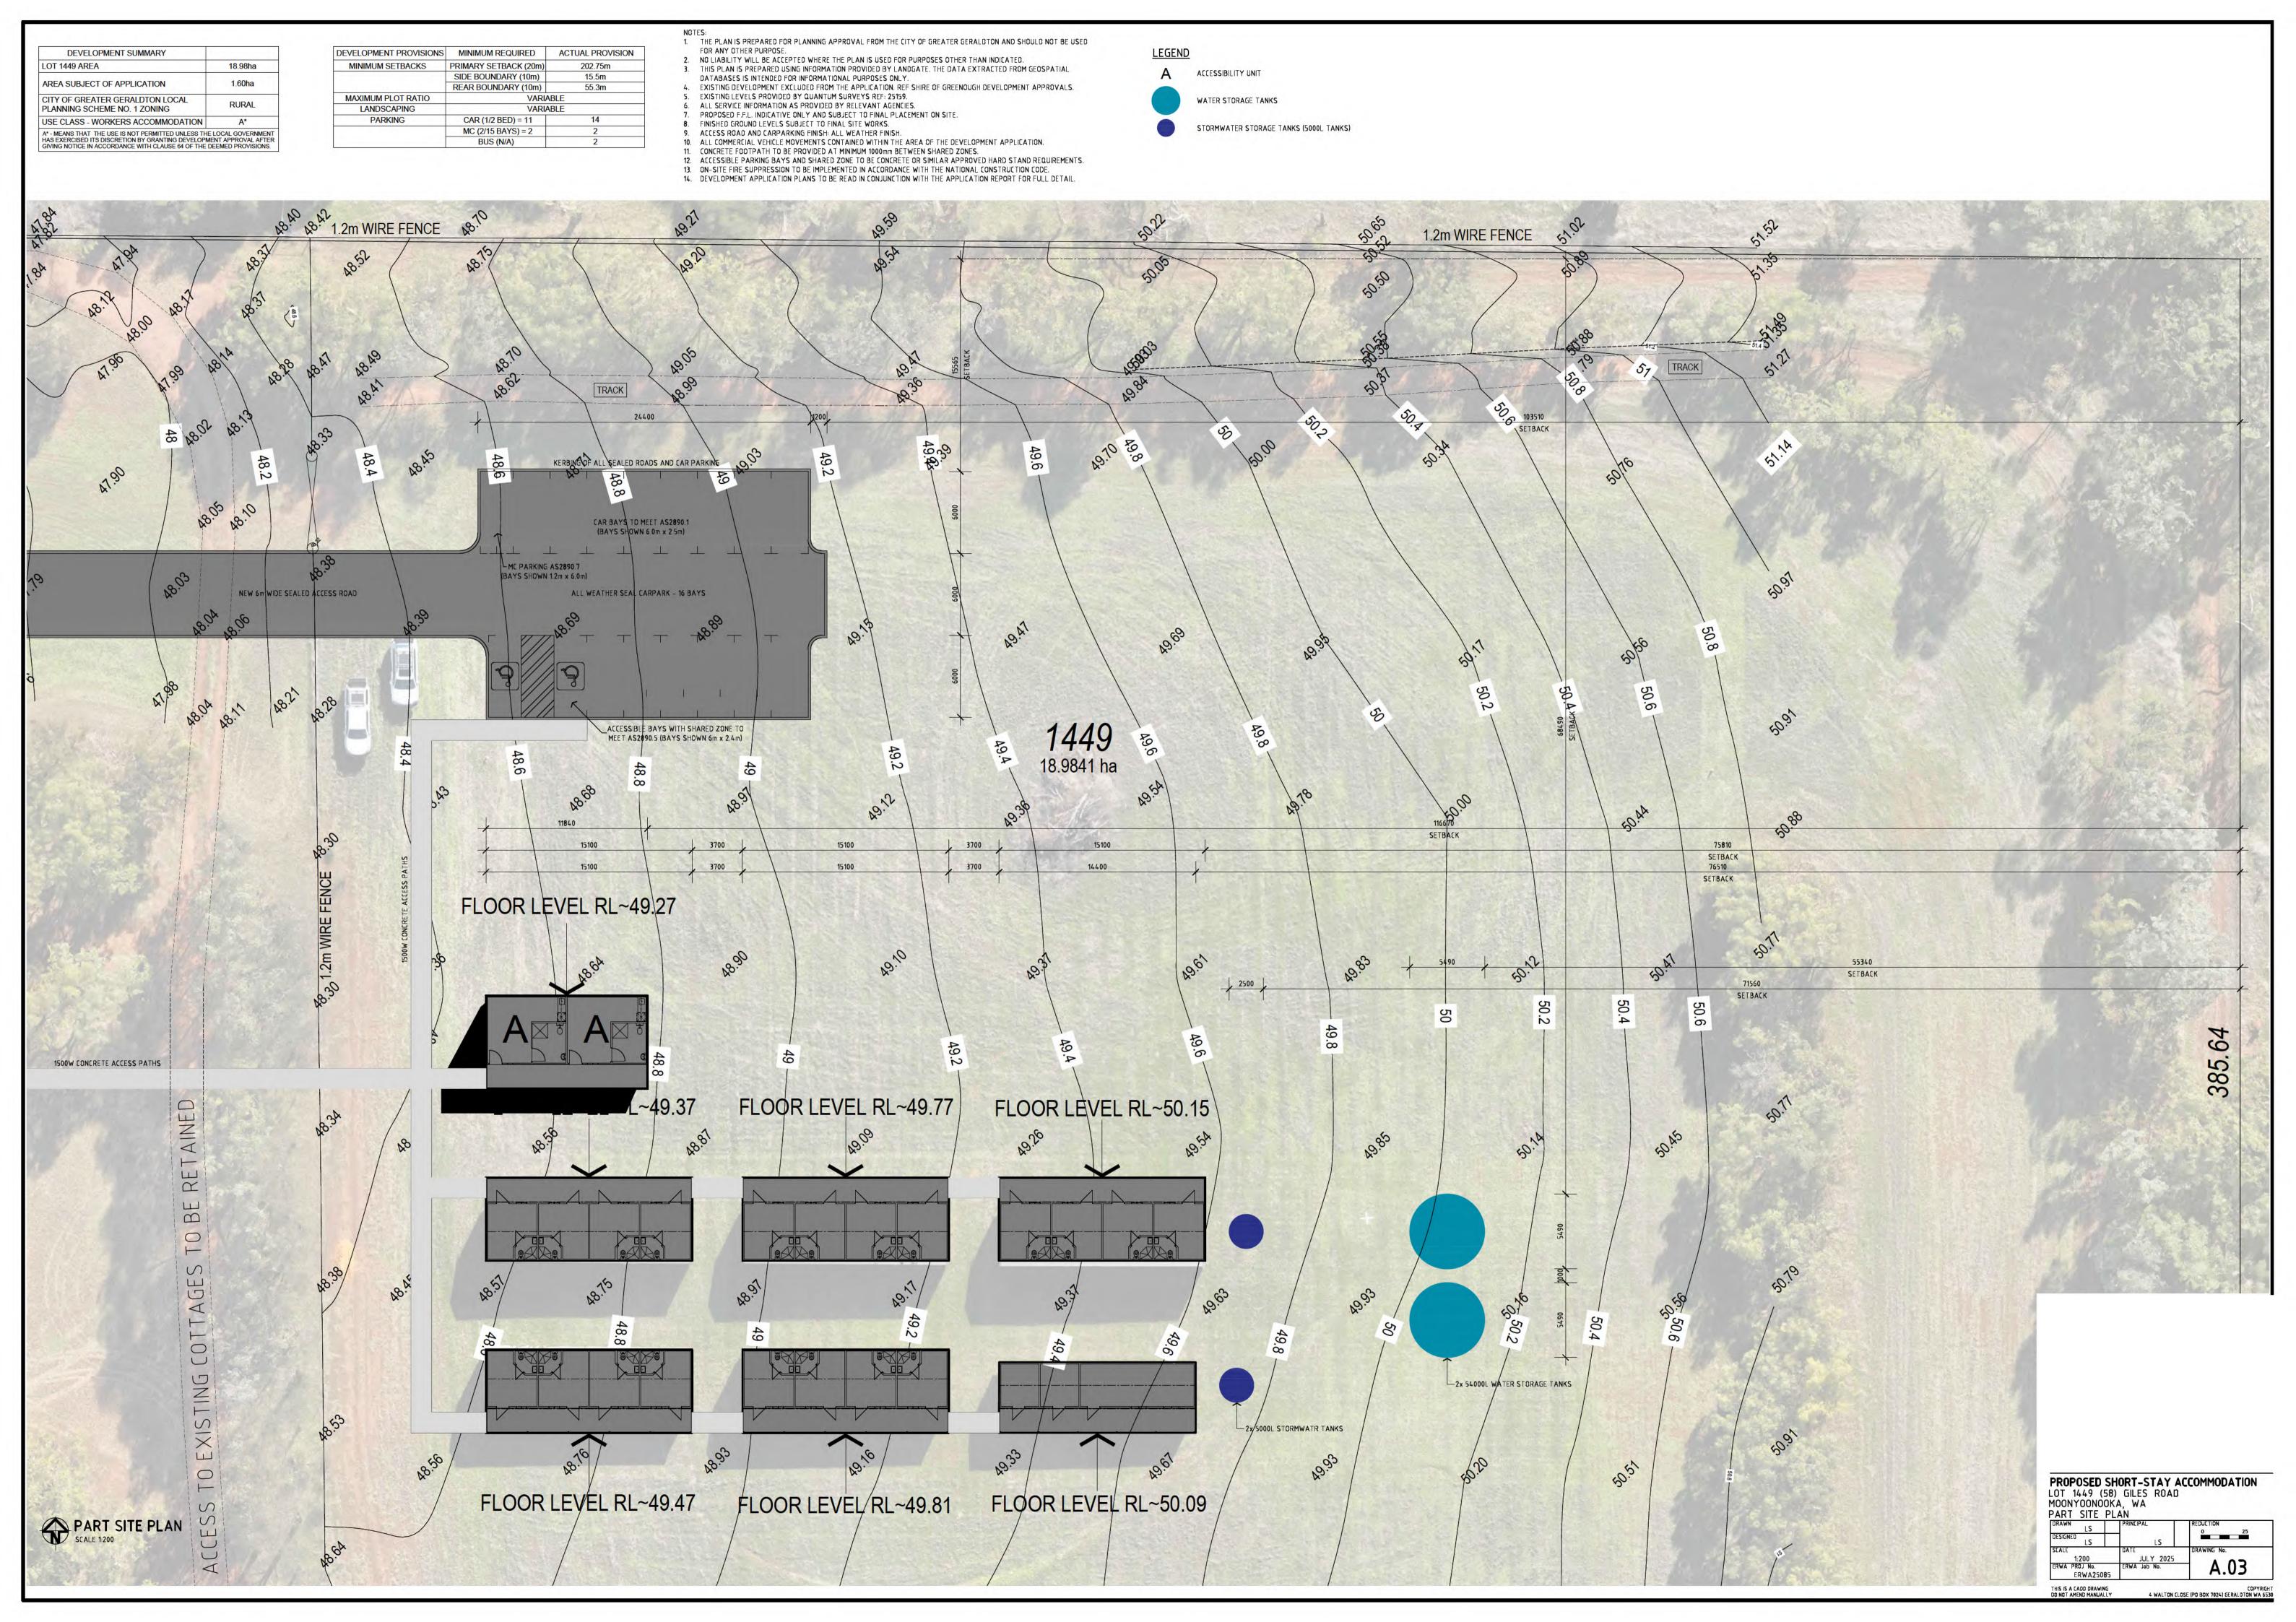



STORM WATER CALCULATIONS - CARPARKING & DRIVEWAY

TOTAL IMPERVIOUS AREA CALCS = 1525 x 0.9 x 0.031. $1525m^2$ x 0.9 x0.031 = $42.54m^3$ VOLUME REQUIRED. ACTUAL SUPPLIED = 2x 1800 ϕ x 1800 ($4.58m^3$) CONCRETE SOAK WELL & 60x10x0.1m DEPRESSED LAND AREA = $69.16m^3$.

DRAINAGE WILL BE CATERED FOR WITH SOAK WELLS. ALL PAVED AREAS TO FALL FORWARD LANDSCAPING.
FINAL LOCATION OF ROOF PLUMBING AND SOAK WELLS TO BE DETERMINED AT DETAILED DESIGN AND BUILDING PHASE.

5. REFER TO INDIVIDUAL BUILDING PLANS FOR DETAILED DRAINAGE CALCUALTIONS TO LOCAL GOVERNMENT SPECIFICATIONS.



PROPOSED SHORT-STAY ACCOMMODATION
LOT 1449 (58) GILES ROAD
MOONYOONOOKA, WA
PART SITE PLAN - SERVICES

PART SITE PLAN - SERVICES

DRAWN LS PRINCIPAL REDUCTION
DESIGNED LS LS


SCALE
1:350
ERWA PROJ No.
ERWA 25085
ERWA 25085

ERWA 25085

ERWA 300 No.
ERWA 25085

CADD DRAWING COPYRIGHT MEND MANUALLY 4 WALTON CLOSE (PO BOX 7024) GERALDTON WA 6530



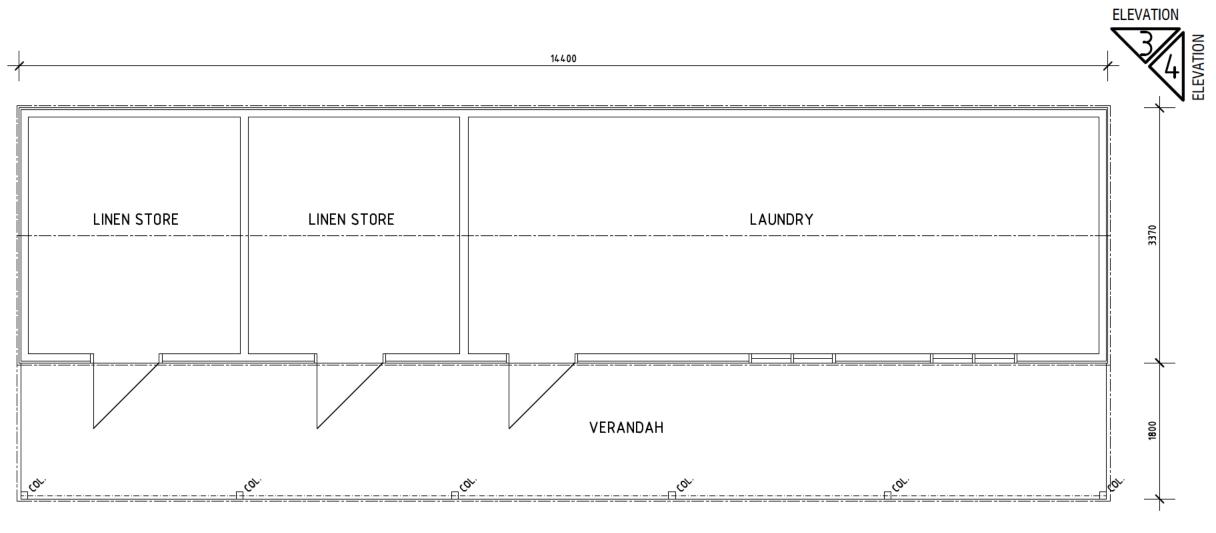

ELEVATION

FLOOR PLAN

HOTEC

1. FINAL POSITION OF ALL STRUCTURES SUBJECT TO AVAILABILITY OF SERVICE CONNECTORS. GENERAL LOCATION INDICATED ON PLAN.

- 2. BUILDING INTERNAL CONFIGURATION AND OPENINGS INDICATIVE ONLY AND MAY CHANGE.
- BUILDINGS TO BE CONNECTED TO RETICULATED WATER, POWER SERVICES AND EFFLUENT DISPOSAL SYSTEMS AS REQUIRED BY THE LOCAL AUTHORITY AND DEPARTMENT OF HEALTH.
- 4. FFL SUBJECT TO BUILDING CERTIFICATION FOR SITE WORKS, FOOTINGS AND METHOD OF TIE DOWN FOR TRANSPORTABLE UNITS.
- 5. STRUCTURE TO BE TIES TO CONCRETE PIERS.
- 6. ALL EXTERNAL WALLS: CUSTOM ORB 'PALE EUCALYPT' WITH 'IRONSTONE' TRIM.
- 7. SPACE BETWEEN GROUND AND FLOOR LEVEL TO BE ENCLOSED IN SIMILAR CLADDING MATERIAL TO WALLS AND FINISHED IN SAME COLOUR PALETTE.

STORM WATER CALCULATIONS

TOTAL IMPERVIOUS AREA CALCS = $75.62 \times 0.9 \times 0.031$. $75.62m^2 \times 0.9 \times 0.031 = 2.11m^3$ VOLUME REQUIRED. ACTUAL SUPPLIED = $1 \times 1800 \phi \times 1800 (4.58m^3)$ CONCRETE SOAK WELL.


DRAINAGE WILL BE CATERED FOR WITH SOAK WELLS. ALL PAVED AREAS TO FALL FORWARD LANDSCAPING.
FINAL LOCATION OF ROOF PLUMBING AND SOAK WELLS TO BE DETERMINED AT DETAILED DESIGN AND BUILDING PHASE.

PROPOSED WORKERS CAMP LOT 1449 (58) GILES ROAD

MOONYOONOOKA, WA FLOOR PLAN - LAUNDRY

DRAWN	PRINCIPAL	REDUCTION
LS		0 25
DESIGNED		
LS	LS	
SCALE	DATE	DRAWING No.
1:50	JUNE 2025	1 4 0 4
ERWA PROJ No.	ERWA Job No.	⊺ A.06
ERWA2508	5	7.00

THIS IS A CADD DRAWING OF NOT AMEND MANUALLY

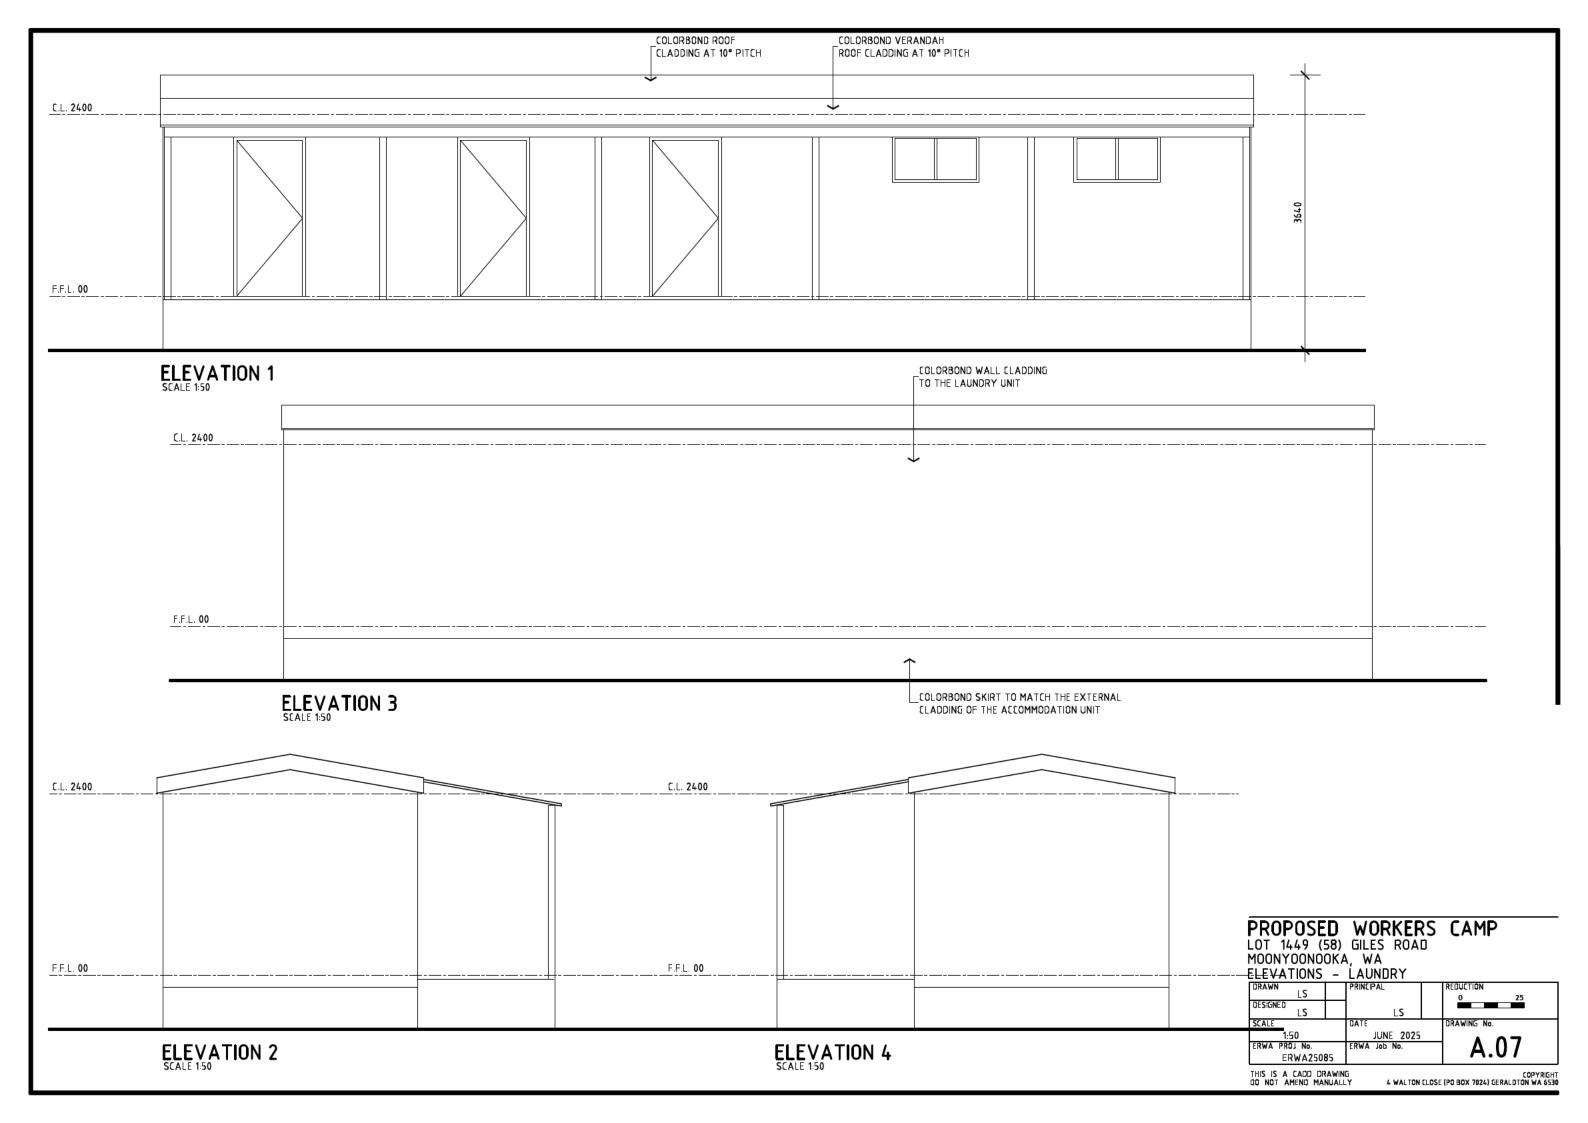

BEDROOM



FLOOR PLAN - ACCOMMODATION BUILDINGS

1. FINAL POSITION OF ALL STRUCTURES SUBJECT TO AVAILABILITY OF SERVICE CONNECTORS. GENERAL LOCATION INDICATED ON PLAN.

2. BUILDING INTERNAL CONFIGURATION AND OPENINGS INDICATIVE ONLY AND MAY CHANGE.

НВ∥

- 3. BUILDINGS TO BE CONNECTED TO RETICULATED WATER, POWER SERVICES AND EFFLUENT DISPOSAL SYSTEMS AS REQUIRED BY THE LOCAL AUTHORITY AND DEPARTMENT OF HEALTH.
- 4. FFL SUBJECT TO BUILDING CERTIFICATION FOR SITE WORKS, FOOTINGS AND METHOD OF TIE DOWN FOR TRANSPORTABLE UNITS.
- 5. STRUCTURE TO BE TIES TO CONCRETE PIERS.
- ALL EXTERNAL WALLS: CUSTOM ORB 'PALE EUCALYPT' WITH 'IRONSTONE' TRIM.
- 7. SPACE BETWEEN GROUND AND FLOOR LEVEL TO BE ENCLOSED IN SIMILAR CLADDING MATERIAL TO WALLS AND FINISHED IN SAME COLOUR PALETTE.

BEDROOM

STORM WATER CALCULATIONS

TOTAL IMPERVIOUS AREA CALCS = 93.69 x 0.9 x 0.031. 93.69m2 x 0.9 x0.031 = 2.61m3 VOLUME REQUIRED. ACTUAL SUPPLIED = 1x 18000 x 1800 (4.58m3) CONCRETE SOAK WELL.

BEDROOM

DRAINAGE WILL BE CATERED FOR WITH SOAK WELLS. ALL PAVED AREAS TO FALL FORWARD LANDSCAPING. FINAL LOCATION OF ROOF PLUMBING AND SOAK WELLS TO BE DETERMINED AT DETAILED DESIGN AND BUILDING PHASE.


PROPOSED WORKERS CAMP LOT 1449 (58) GILES ROAD


MOONYOONOOKA, WA

FLOOR PLAN - ACCOMMODATION UNITS

DRAWN	PRINCIPAL	REDUCTION
LS	1	0 25
DESIGNED		
LS	LS	
SCALE	DATE	DRAWING No.
1:50	JUNE 2025	1 4 00
ERWA PROJ No.	ERWA Job No.	□ A.08
ERWA2508	5	7.00

BEDROOM

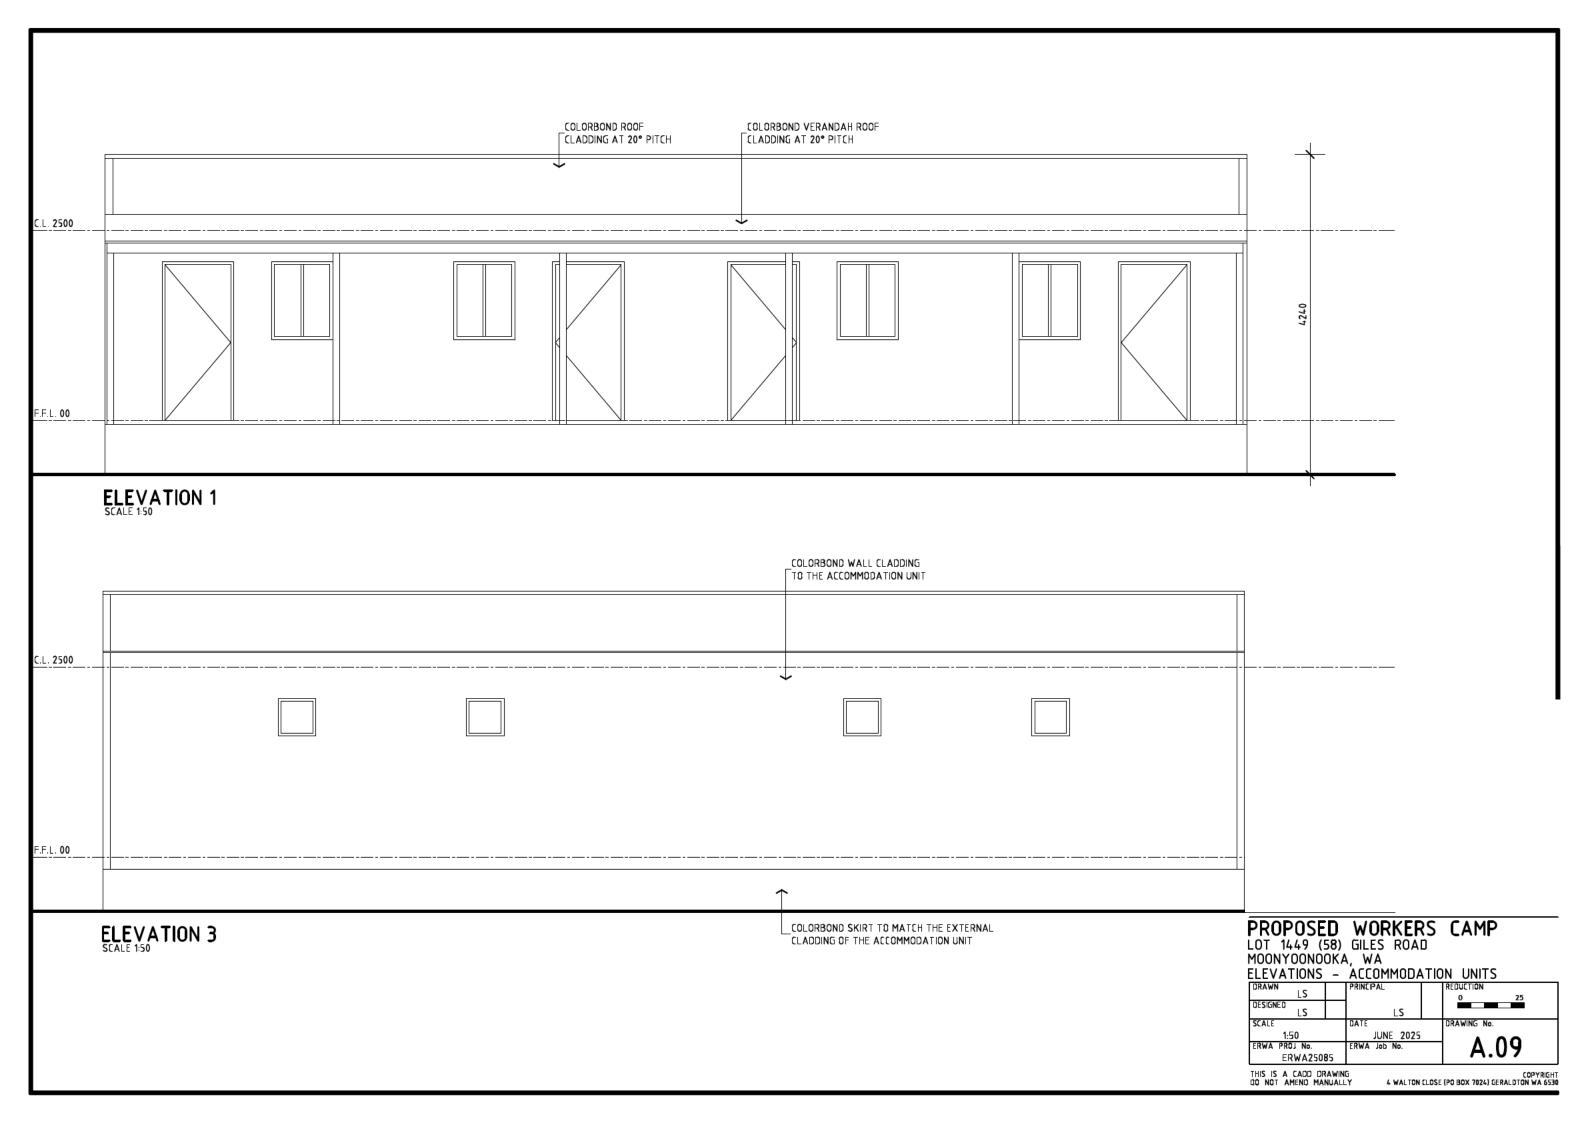


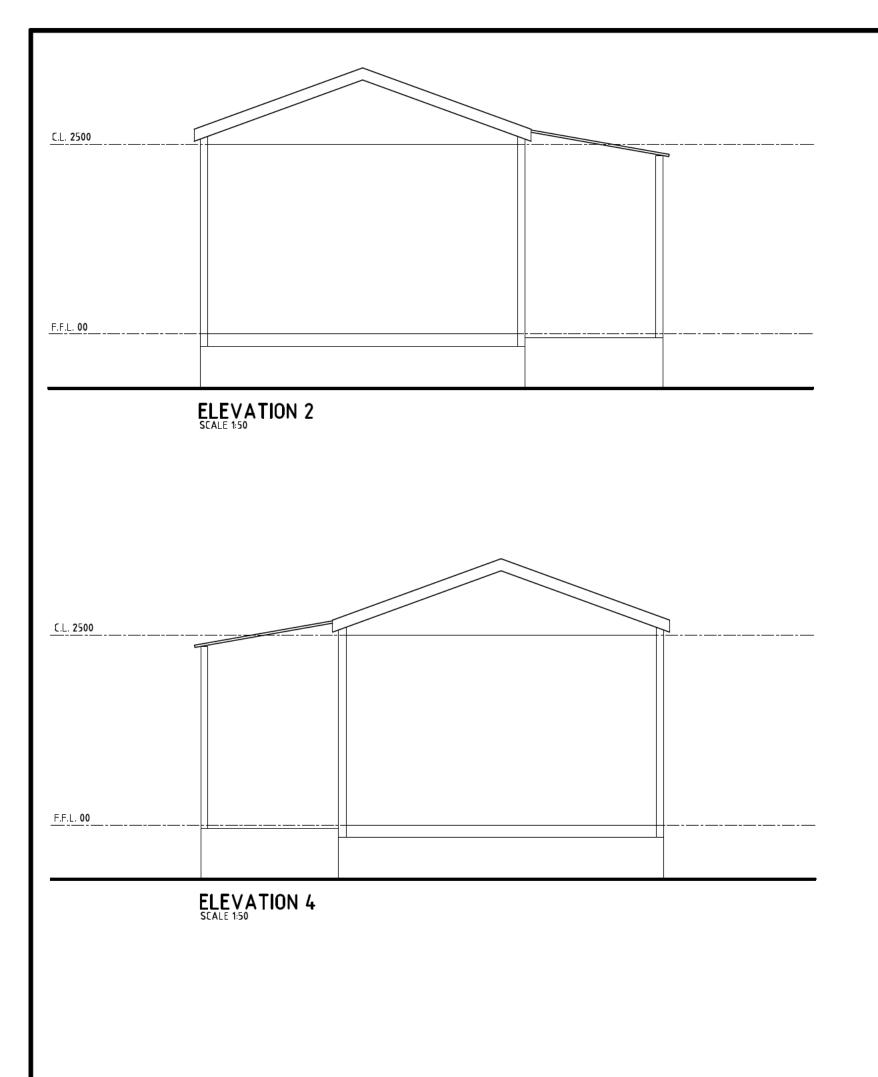

PROPOSED WORKERS CAMP LOT 1449 (58) GILES ROAD MOONYOONOOKA, WA ELEVATIONS - ACCOMMODATION UNITS

		, (CCO) 11 10D;	 0.11.13
DRAWN		PRINCIPAL	REDUCTION
DESIGNED LS		LS	0 25
SCALE		DATE	DRAWING No.
1:50		JUNE 2025	A 40
ERWA PROJ No.		ERWA Job No.	Ι Δ 1()
ERWA2508	35		71.10

THIS IS A CADD DRAWING OF NOT AMEND MANUALLY

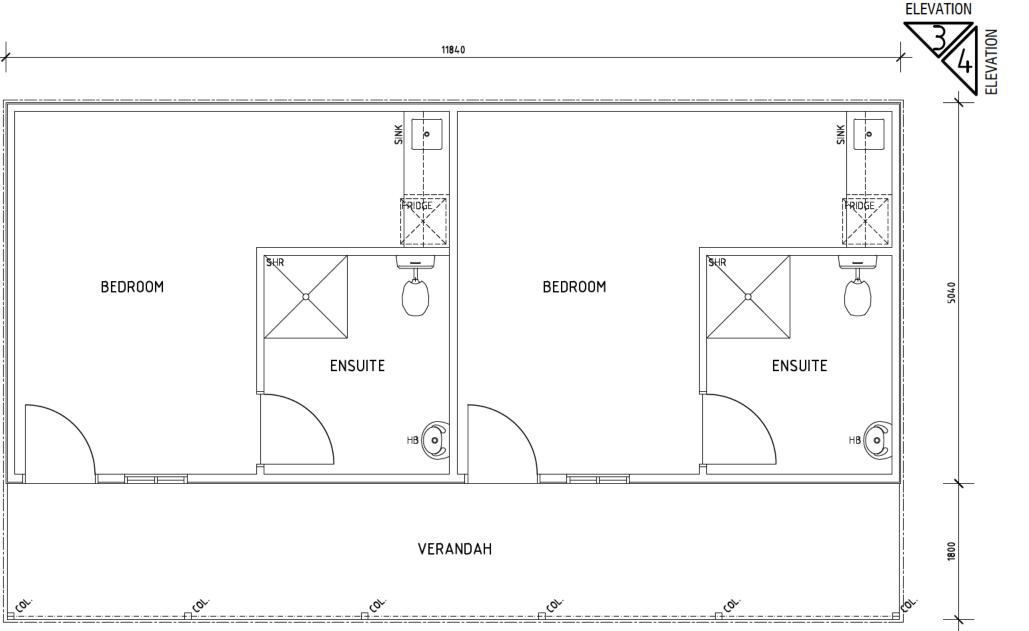

ELEVATION **ELEVATION**

FLOOR PLAN

NOTES:

- FINAL POSITION OF ALL STRUCTURES SUBJECT TO AVAILABILITY OF SERVICE CONNECTORS. GENERAL LOCATION INDICATED ON PLAN.
- BUILDING INTERNAL CONFIGURATION AND OPENINGS INDICATIVE ONLY AND MAY CHANGE.
- BUILDINGS TO BE CONNECTED TO RETICULATED WATER, POWER SERVICES AND EFFLUENT DISPOSAL SYSTEMS AS REQUIRED BY THE LOCAL AUTHORITY AND DEPARTMENT OF HEALTH.
- 4. FFL SUBJECT TO BUILDING CERTIFICATION FOR SITE WORKS, FOOTINGS AND METHOD OF TIE DOWN FOR TRANSPORTABLE UNITS.
- STRUCTURE TO BE TIES TO CONCRETE PIERS.
- ALL EXTERNAL WALLS: CUSTOM ORB 'PALE EUCALYPT' WITH 'IRONSTONE' TRIM.
- 7. SPACE BETWEEN GROUND AND FLOOR LEVEL TO BE ENCLOSED IN SIMILAR CLADDING MATERIAL TO WALLS AND FINISHED IN SAME COLOUR PALETTE.

STORM WATER CALCULATIONS

TOTAL IMPERVIOUS AREA CALCS = 82.11 x 0.9 x 0.031. 82.11m2 x 0.9 x0.031 = 2.29m3 VOLUME REQUIRED. ACTUAL SUPPLIED = 1x 18000 x 1800 (4.58m3) CONCRETE SOAK WELL.


DRAINAGE WILL BE CATERED FOR WITH SOAK WELLS. ALL PAVED AREAS TO FALL FORWARD LANDSCAPING. FINAL LOCATION OF ROOF PLUMBING AND SOAK WELLS TO BE DETERMINED AT DETAILED DESIGN AND BUILDING PHASE.


PROPOSED WORKERS CAMP LOT 1449 (58) GILES ROAD

MOONYOONOOKA, WA

FLOOR PLAN - DISABLED ACCOMMODATION UNIT

	DISTIBLED	,,cco,,,,ob,,,,,o,,,
DRAWN	PRINCIPAL	REDUCTION
LS	1	0 25
DESIGNED S	ıs	
SCALE	DATE	DRAWING No.
1:50	JUNE 2025	_
ERWA PROJ No.	ERWA Job No.	□ Δ 11 I
ERWA25085		7.11

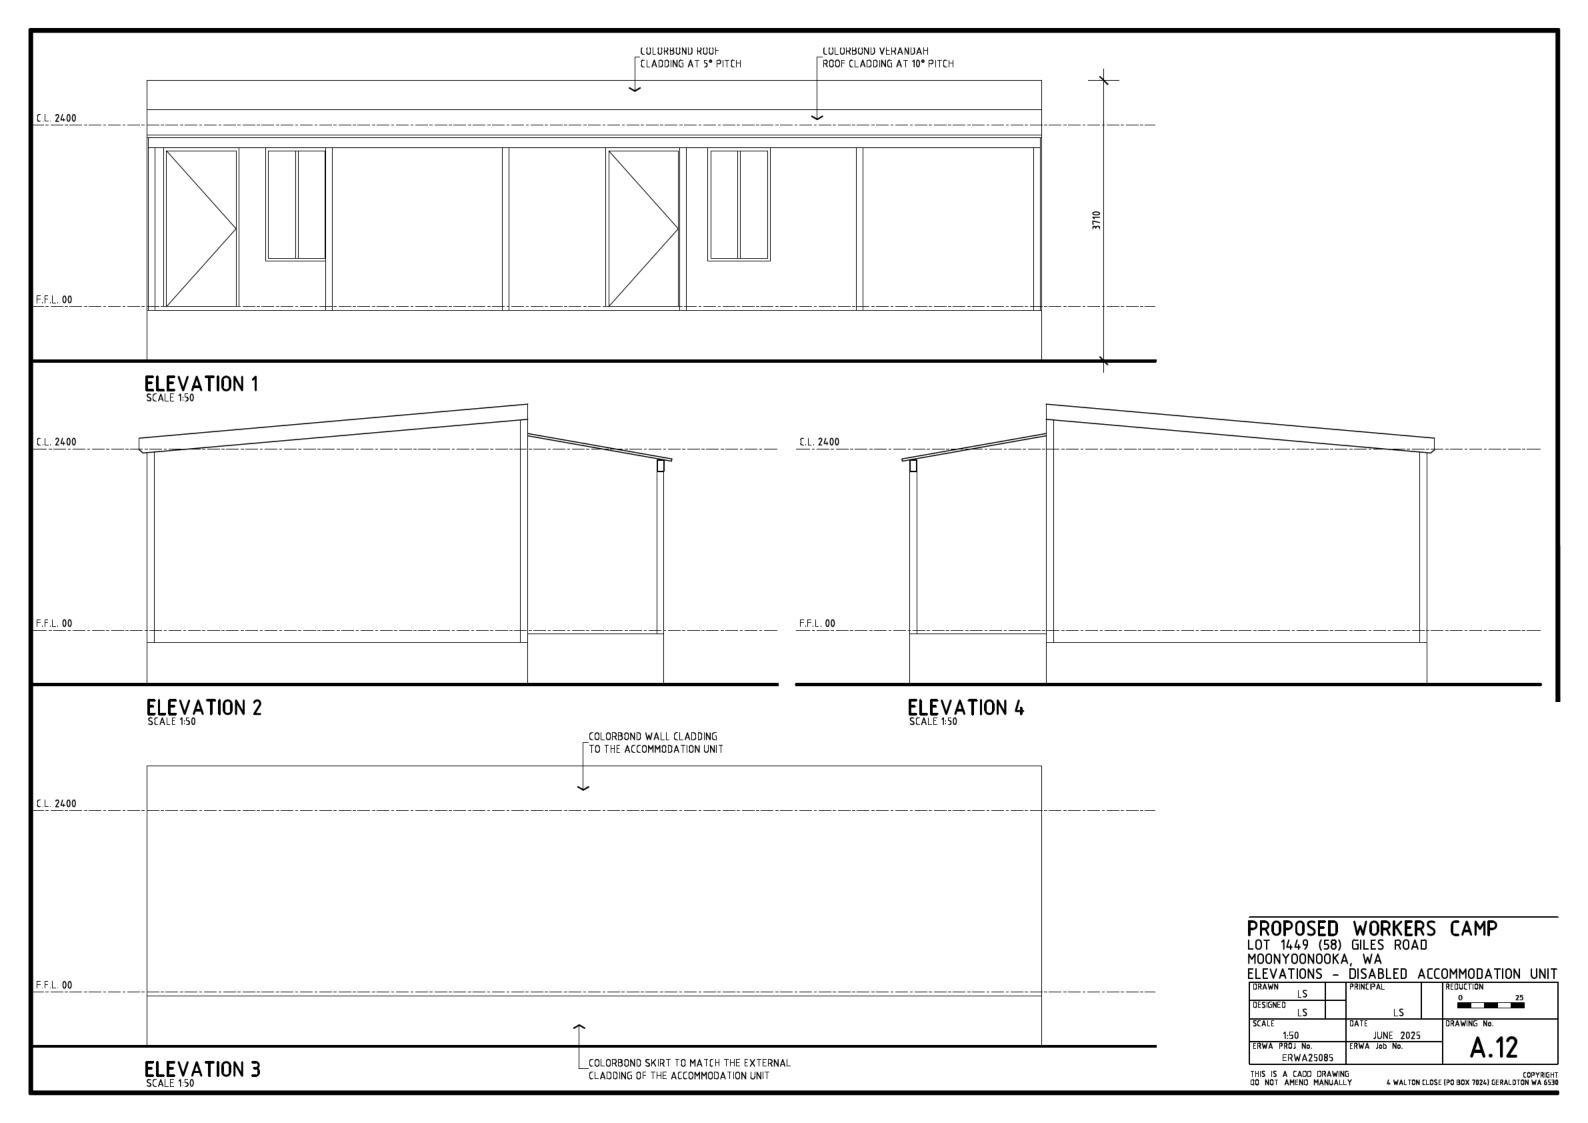


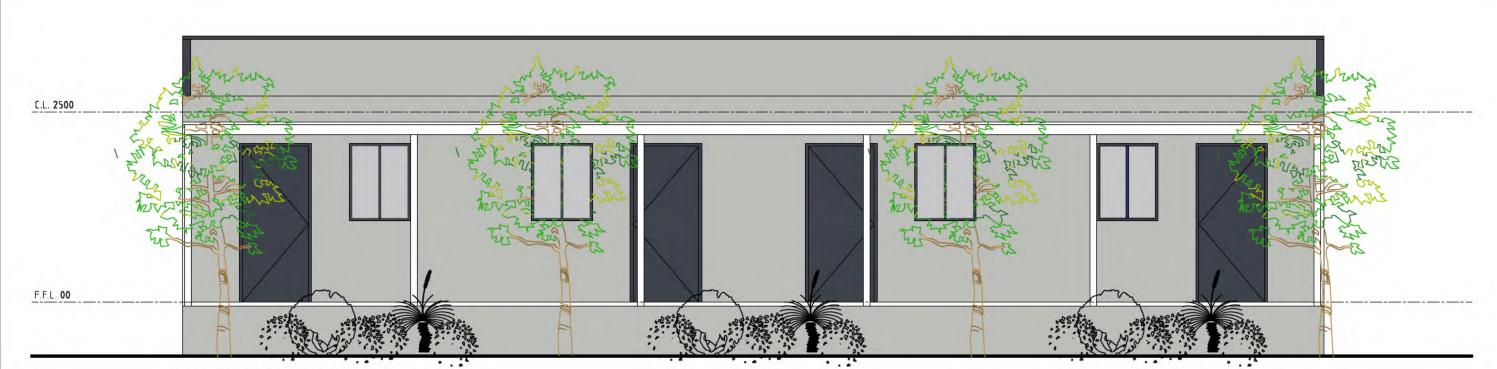

FRONT ELEVATION SCALE 1:50

NOTES:

- INDICATIVE BUILT FORM ONLY.
 WALLS AND SKIRT: COLORBOND FALE EUCALYPT.
 TRIM: COLORBOND IRONSTONE.

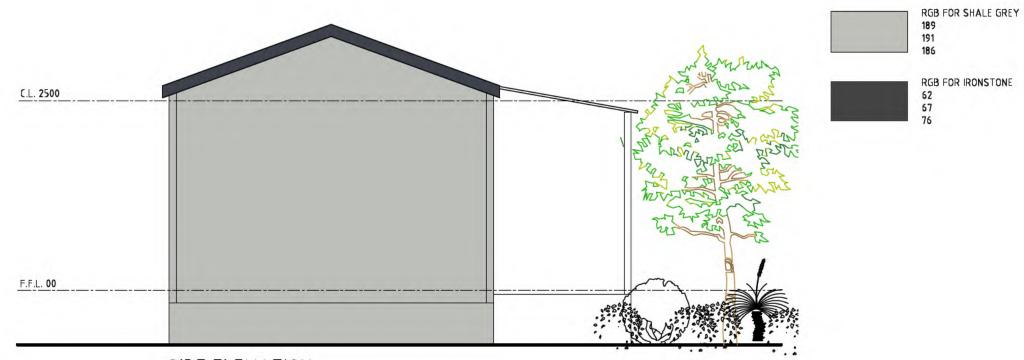

SIDE ELEVATION

PROPOSED WORKERS CAMP LOT 1449 (58) GILES ROAD MOONYOONOOKA, WA ELEVATIONS - AS BUILT

DRAWN LS	PRINCIPAL	REDUCTION 0 25
DESIGNED LS	LS	
SCALE 1:50	JUNE 2025	DRAWING No.
ERWA PROJ No. ERWA25085	ERWA Job No.	□ A.13

THIS IS A CADD DRAWING DO NOT AMEND MANUALLY